

Rev	Description	By	Date
A	ISSUE TO CLIENT	TS	2024-08-14
B	ISSUE TO CONSULTANTS	TS	2024-08-21
C	ISSUE TO MECHANICALS	TS	2024-09-26
D	ISSUE TO DOOR HARDWARE	TS	2024-10-07
E	ISSUE FOR BUILDING LICENSE	TS	2024-11-12
1	STAIR 01 BALUSTRADE	TS	2025-05-01
2	STAIR 01 BALUSTRADE AMENDMENT	TS	2025-05-03
3	ISSUE FOR CONSTRUCTION ADDENDUM	TS	2025-05-05
4	REVISED LEVEL 2	TS	2025-07-25

Compliance Consultant Suite 3/48 Kitchener Road, Applecross WA 6153	Resolve Group Pty Ltd
Structural Engineers 1064 Hay Street, West Perth, WA, 6005	Forth Engineering
Mechanical Engineers 5300 Roxbury Rd Subiaco, WA, 6008	DSA Pty Ltd
Electrical Engineers 251 Adelaide Terrace, Perth WA 6000	E-Consulting Engineers
Fire Engineers PO Box 340, Quinns Rock WA 6030	Xero Fire
Hydraulic Engineers 17 Seagraves St West Leederville WA 6007	Dalton Rodan & Associates
Surveyor Unit 1, 9 Mercer Lane, Joondalup 6027	Ross McLoughlin

NOTE:
 REFER TO MATERIAL CODE SUMMARY FOR MATERIAL SELECTIONS.
 CHECK ON SITE ALL DIMENSIONS AND SITE CONDITIONS PRIOR TO ANY WORK COMMENCING.

Cox Architecture
 360 Murray Street
 Perth WA 6000
 Australia
 T + 61 8 9322 3644
 coxarchitecture.com.au




Client PP 356 Murray Street Pty Ltd at PrimePrivate 356 Murray Street Trust
Project No. 622113
Project 356 Murray Street Refurbishment
 356 Murray Street, Perth WA 6000
Acknowledgement

Drawing Title LEVEL 2 FLOOR PLAN PROPOSED

Document Control Status:

ISSUE FOR CONSTRUCTION

Co-ordinated:	TS	Drawn:	TG
Project Architect:	TS	Scale:	As indicated @ A1
Project Director:	FF	Date:	09/08/2024
Drawing Number:	A-21-03	Revision:	4

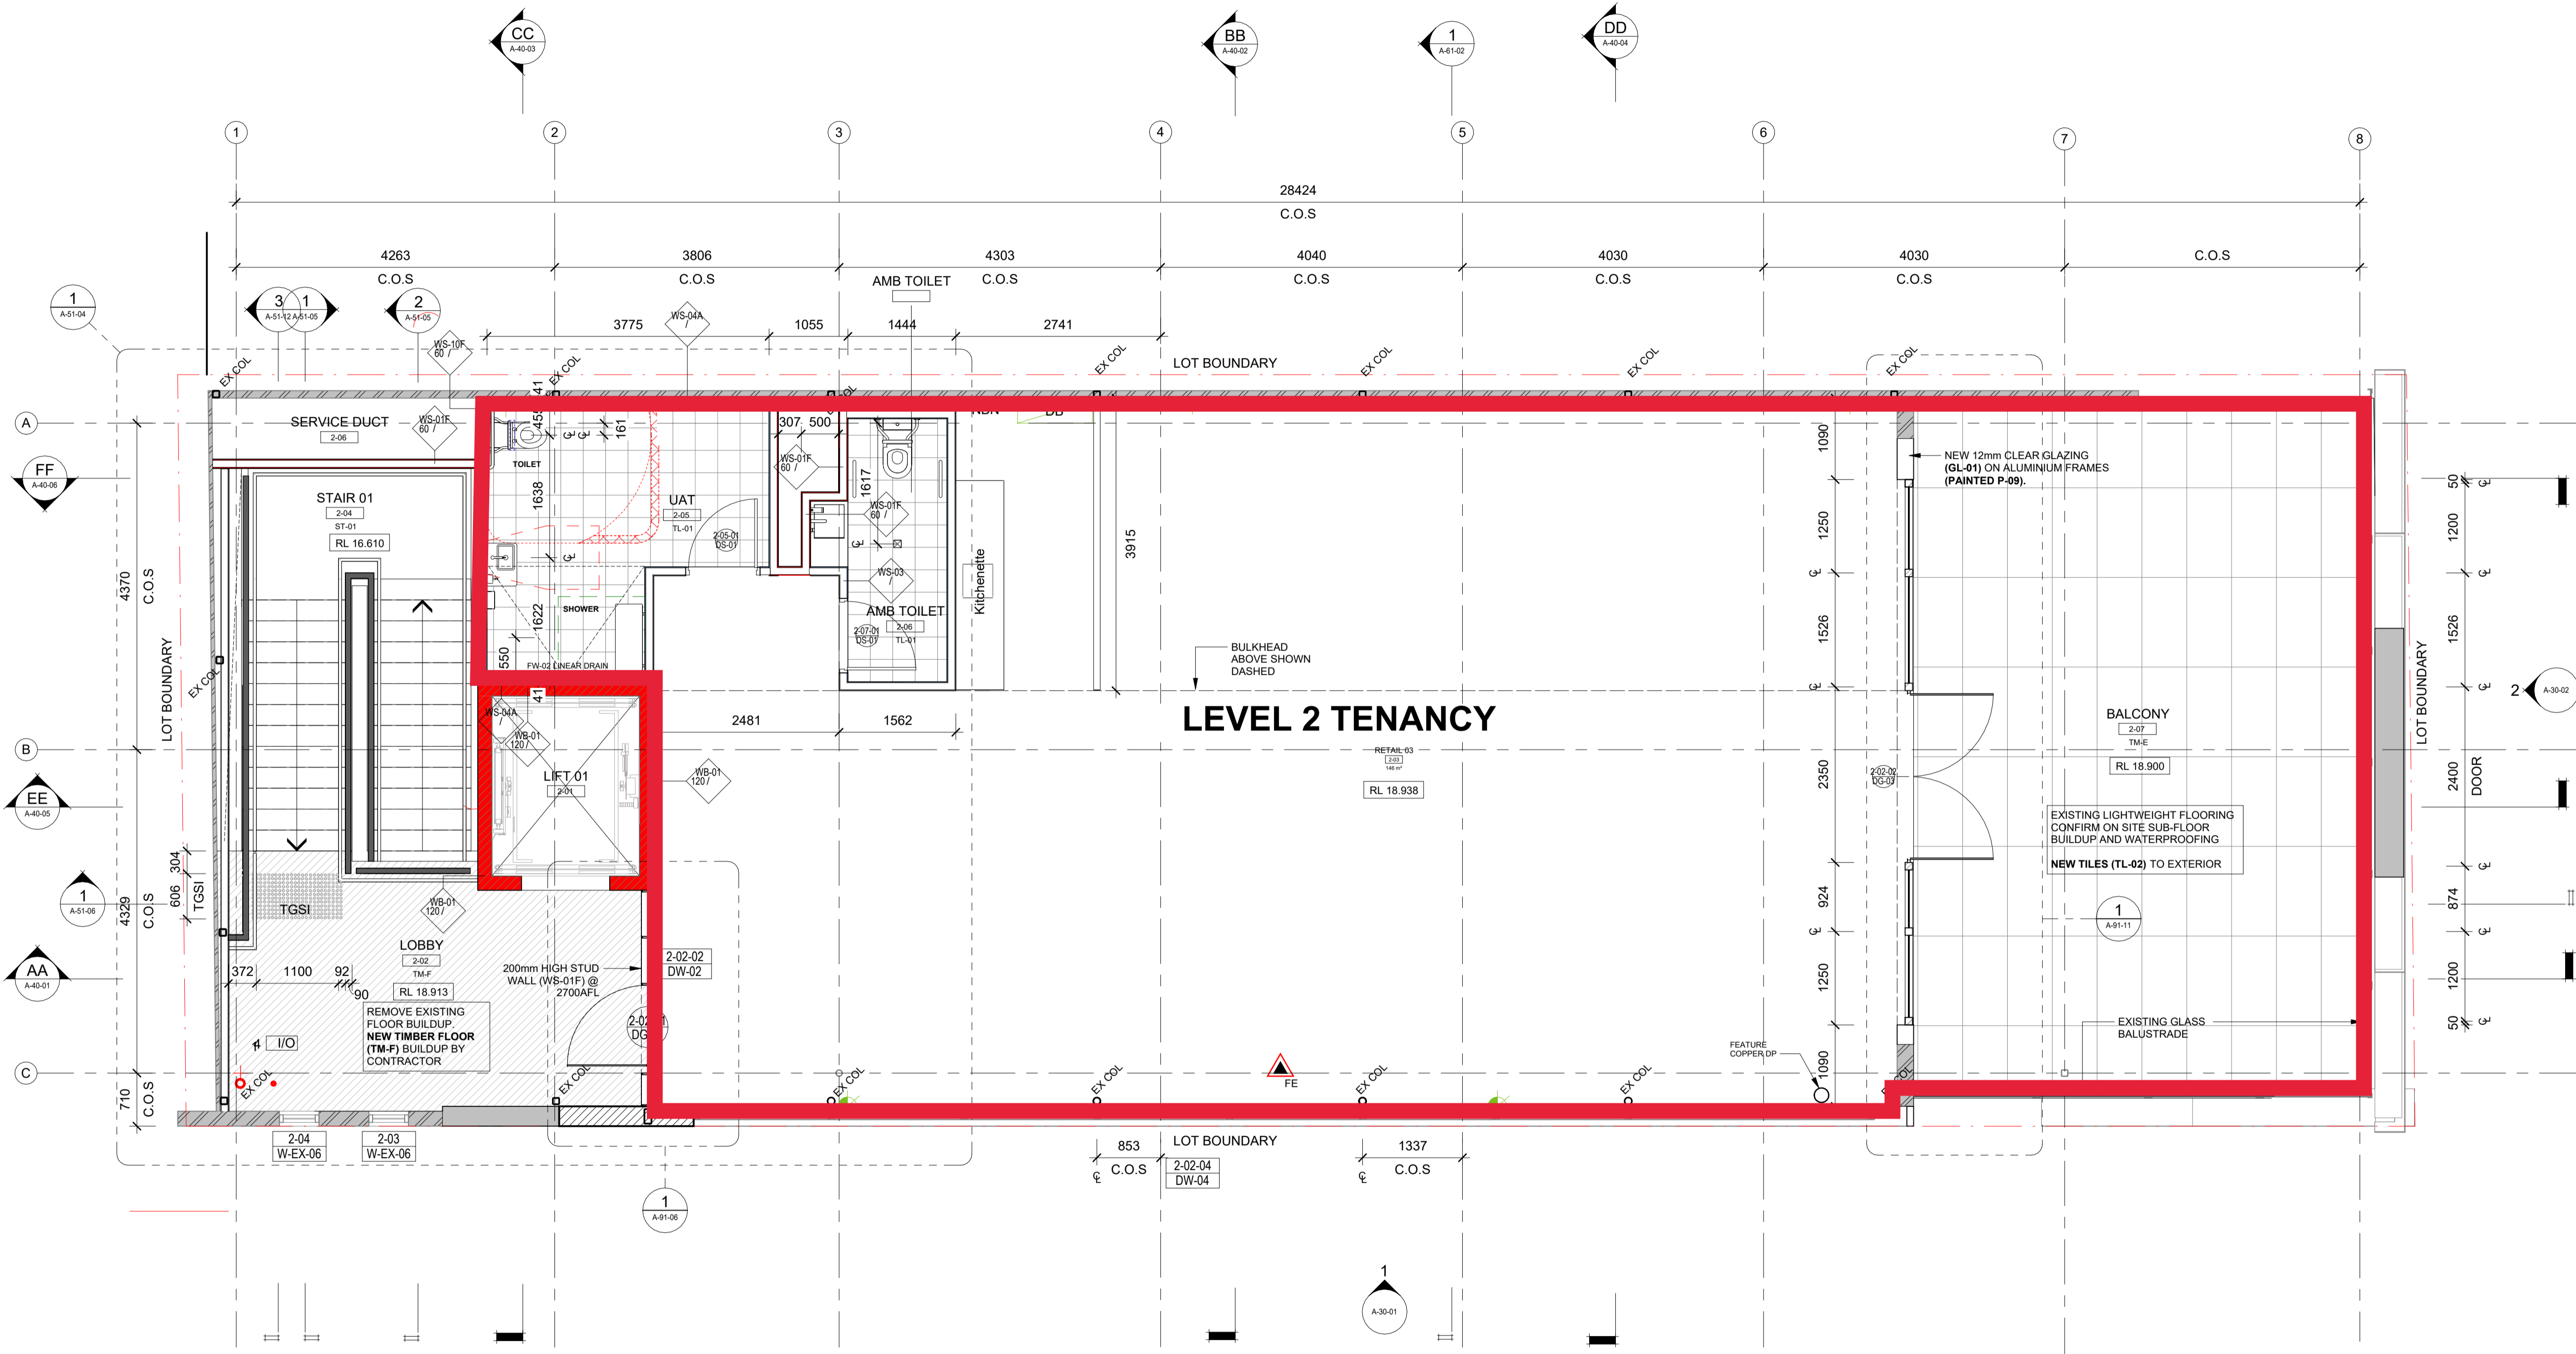

1 LEVEL 2 PROPOSED PLAN
 SCALE 1 : 50

LEGEND: PLANS

<p>RL X.XXX EXISTING SPOT LEVEL (METRES) ABOVE DATUM.</p> <p>RL X.XXX PROPOSED SPOT LEVEL (METRES) ABOVE DATUM.</p> <p>FFL X.XXX PROPOSED FINISH FLOOR LEVEL (METRES) ABOVE DATUM.</p> <p>PROPERTY BOUNDARY SETOUT POINT</p>	<p>ROOM NAME [T-001] FLOOR FINISH 1500</p> <p>ROOM TAG WITH NAME, NUMBER & FLOOR FINISH</p> <p>GENERAL DIMENSIONS (DIAGONAL)</p> <p>DIMENSIONS TO GRID (DOT)</p> <p>NEW TIMBER FLOOR TO MATCH EXISTING</p>	<p>WALLS WALL TAG: [W-01] WALL TYPE FIRE / ACOUSTIC RATING WALL HEIGHT</p> <p>FIRE RATING: 030 = 30 MINUTES (FRL - / 30 / 30) 060 = 60 MINUTES (FRL - / 60 / 60) 090 = 90 MINUTES (FRL - / 90 / 90) 120 = 120 MINUTES (FRL - / 120 / 120) 180 = 180 MINUTES (FRL - / 180 / 180)</p> <p>ACOUSTIC RATINGS: UNITS GIVEN IN RW (WEIGHTED SOUND REDUCTION INDEX) WALL HEIGHT: 1 = FULL HEIGHT TO UNDERSIDE OF ROOF / FLOOR STRUCTURE 2 = 100mm (MIN) ABOVE CEILING 3 = UNDERSIDE OF CEILING 4 = AS INDICATED ON ELEVATION 5 = ABOVE GLAZING TO U/S OF ROOF/FLOOR STRUCTURE 2400 = HEIGHT (MM) ABOVE FINISH FLOOR LEVEL</p>	<p>EXISTING WALLS / COLUMNS</p> <p>FIRE WALLS / SEPARATION</p> <p>NEW FINISH. REFER TO SCHEDULE</p> <p>SK-XX NEW SKIRTING WITH PAINT FINISH. REFER TO SCHEDULE</p> <p>WINDOWS WINDOW TAG: [G-XX] GLAZING NUMBER [FT-XX] FRAME TYPE</p>	<p>DOORS DOOR TAG: [G-XX] DOOR NUMBER [DX-XX] DOOR TYPE</p> <p>NEW DOOR</p> <p>EXISTING DOOR</p> <p>B/I 3mm BRASS INLAY</p> <p>S/T STEEL TRIM</p> <p>C/J CONTROL JOINT</p> <p>J PANEL JOINT</p>	<p>SD-01 SLOT DRAIN. REFER TO HYDRAULIC SPECIFICATION</p> <p>FB NEW FLOOR BOX</p> <p>FW FLOOR WASTE</p> <p>FHR FIRE HOSE REEL</p> <p>FH NEW FIRE HYDRANT</p> <p>WALL MOUNTED LIGHTING</p> <p>FALL RISK MITIGATION</p> <p>NEW FIRE EXTINGUISHER</p> <p>FIRE INDICATOR PANEL</p>
--	--	---	--	---	--